

Installation manual

Log cabin LAS VEGAS


Width 430 x Depth 320 cm



Log thickness 44 mm



The producer shall have the right to make technical changes to the product • Technische Änderungen vorbehalten • Le producteur réserve le droit d'effectuer des modifications techniques au produit • Il produttore mantiene il diritto di apportare modifiche tecniche al prodotto • Reservado el derecho a modificaciones técnicas • Producent forbeholder seg retten til å endre tekniske egenskaper ved produktet • Alle rechten en technische wijzigingen voorbehouden • Výrobce si vyhrazuje právo na technické změny výrobku • Valmistaja pidättää oikeuden tehdä tuotteeseen teknisiä muutoksia • Tillverkaren har rätt att utföra tekniska förändringar för produkten • Producent zastrzega sobie prawo do dokonywania zmian technicznych produktu

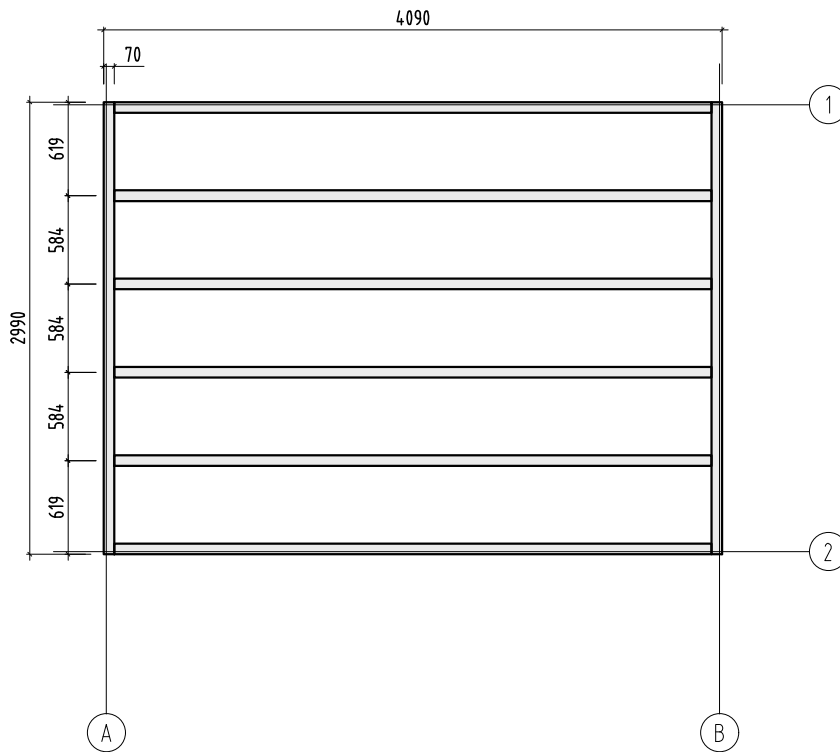

Object name
PM44-434


Drawing
Plan

Scale 1:50
Paper A4

Palmako
LEMEKS GROUP


AS Palmako
Näituse 25, Tartu 50409, Estonia
tel. +372 73 55 530
fax. +372 73 55 544
www.palmako.com

Customer	ST	Log	44x114
Drawn by	350		
Date	02.10.2017	File	Heidi_11.7_m2.dwg

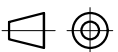

Page 1

H = 1.500 m
TOTAL: 11.68 m²

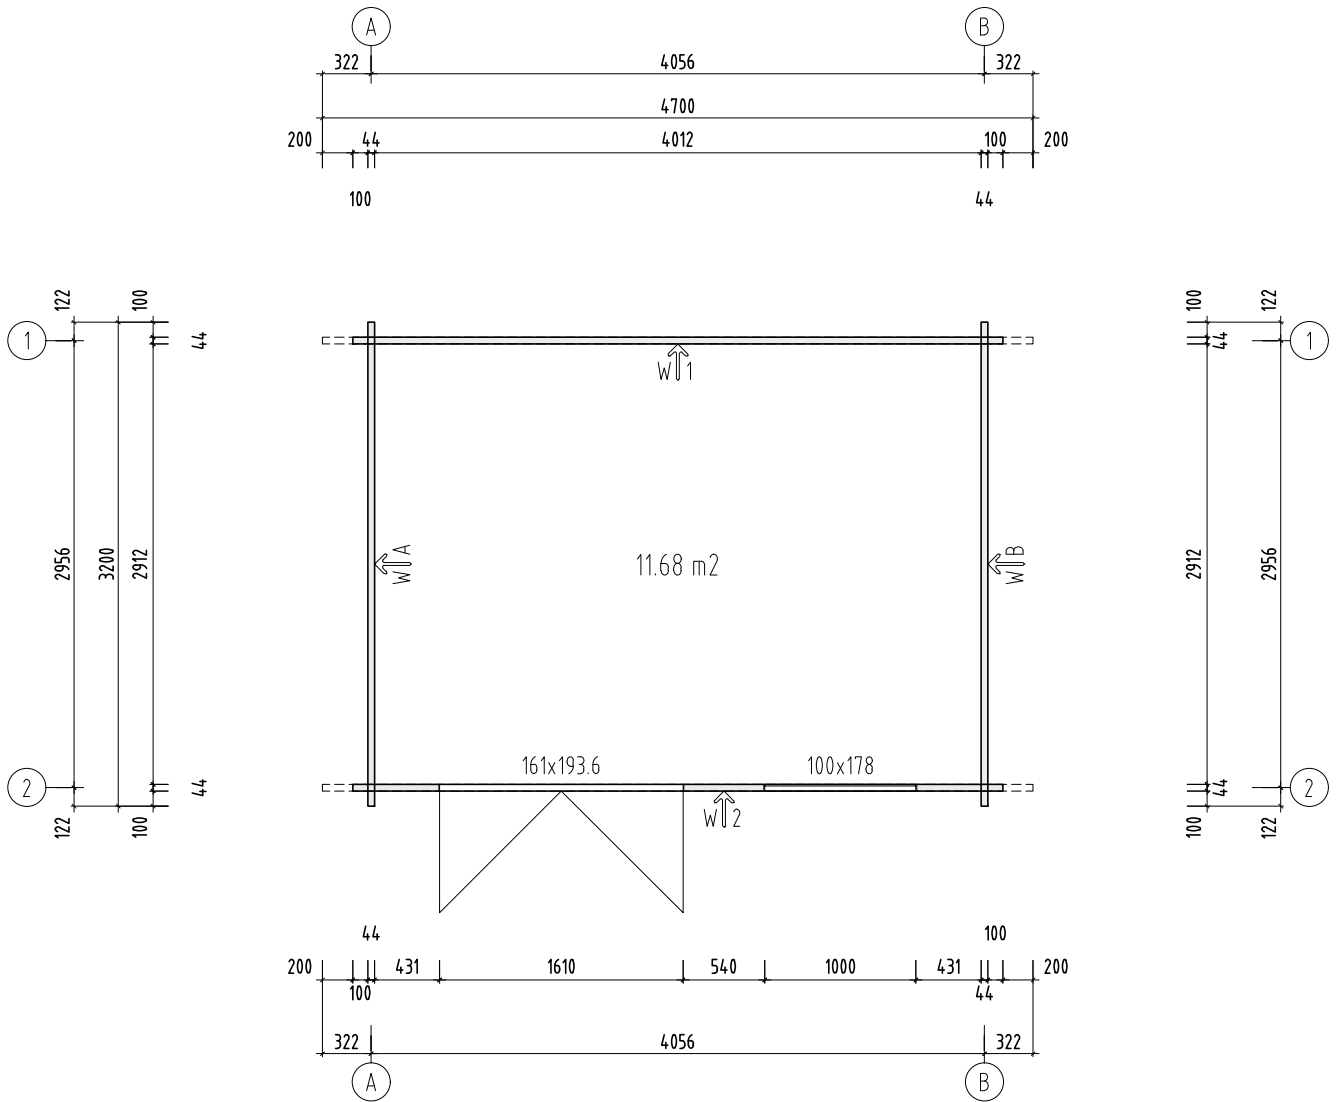

Object name
PM44-434

Drawing
Plan H=1.5m





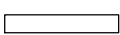
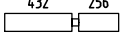
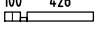
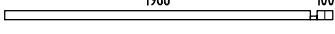
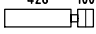
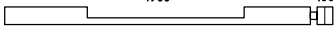
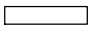
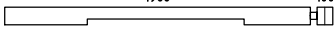
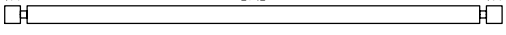
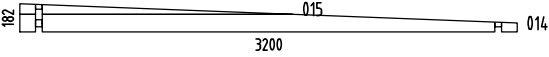
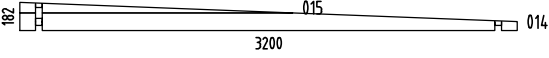
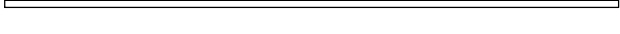



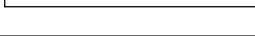
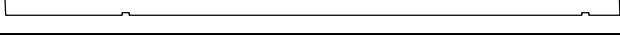




Scale 1:50
Paper A4


Palmako
LEMEKS GROUP

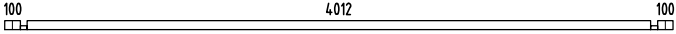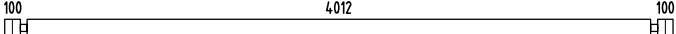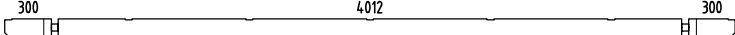
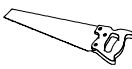

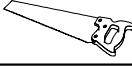






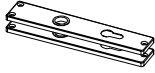
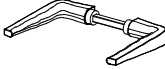




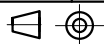





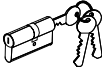





AS Palmako
Näituse 25, Tartu 50409, Estonia
tel. +372 73 55 530
fax. +372 73 55 544
www.palmako.com

Customer	ST	Log	44x114
Drawn by	350		
Date	02.10.2017	File	Heidi_11.7_m2.dwg







Page 1

Pos	SPECIFICATION-STÜCKLISTE-NOMENCLATURE-ELEMENTI-ESPECIFICACIÓN PM44-434	Pcs	Profile (mm)	Length (mm)
001		1	44x57	4300
002		18	44x114	4300
003		2	44x114	4700
004		2	44x114	732
005		8	44x114	732
006		2	44x114	732
007		1	44x57	570
008		1	44x57	2110
009		32	44x114	570
010		1	44x114	2110
011		15	44x114	530
012		1	44x114	2110
013		38	44x114	3200
WA-1		1		
WB-1		1		
AR2	Foundation- Fundament- Fondation- Fondazione- Vigas de cimentación 	6	70x45	3950
AR1	Foundation- Fundament- Fondation- Fondazione- Vigas de cimentación 	2	70x45	2990
EaE1	Eave edging- Dachrandbrett- Madrier en bordure du toit- Tavola bordo tetto- Tabla de valadizo 	8	19x120	2390
EaE3	Eave edging- Dachrandbrett- Madrier en bordure du toit- Tavola bordo tetto- Tabla de valadizo 	2	19x70	3165
EaE2	Eave edging- Dachrandbrett- Madrier en bordure du toit- Tavola bordo tetto- Tabla de valadizo 	2	19x70	1615
RoR1	Rafter- Sparre- Chevron- Trave- Cabrio 	7	44x140	3958
Sla1	Slat- Leiste- Bagueffe- Listello- Listón 	1	45x19	1620
FB2-1	Floor board- Fussbodenbrett- Madrier du plancher - Tavola pavimento- Tabla de suelo 	45	89x19	2905
RB2-1	Roof board- Dachbrett- Madrier du toit- Tavola tetto- Tabla de tejado 	45	89x19	4700
FaB7-1	Facia board- Giebelblende- Écran frontal- Schermo frontone- Tabla de facia 	4	19x120	4050




Pos	SPECIFICATION-STÜCKLISTE-NOMENCLATURE-ELEMENTI-ESPECIFICACIÓN PM44-434	Pcs	Profile (mm)	Length (mm)		
FaB5-1	Facia board- Giebelblende- Écran frontal- Schermo frontone- Tabla de facia			2	19x70	4050
FIB2-1	Floor beading- Fussbodenleiste- Baguette du plancher- Listello pavimento- Listón de suelo			7	19x19	2050
Sis1-1	Side slat- Randleiste- Baguette en bordure- Listón de borde- Listello bordo			1	19x70	962
Sis1-2	Side slat- Randleiste- Baguette en bordure- Listón de borde- Listello bordo			4	19x70	1831
Sis2-1	Side slat- Randleiste- Baguette en bordure- Listón de borde- Listello bordo			2	19x95	1102
Fim	-Fixing kit- Befestigungsset- Moyens de fixation- Materiale di fissaggio- Kit de fijación			1	USE	
QULSy damik 30/35	Cylinder- Zylinderschloss- Serrure a mortaiser- Serratura a cilindro- Bombin- 30.35			1	TU44-102P	
QVeepl ekk962	Detail- Detail- Detail- Dettaglio- Detalle- Veeplekk962			1	A44-68	
QULKat eHOBEk	Door fittings- Türbeschlag- Ferrure- Ferramenta porta- Manilla puerta- QULKateHOBEk			1	TU44-102P	
QULLi nkHOBE	Door fittings- Türbeschlag- Ferrure- Ferramenta porta- Manilla puerta- QULLinkHOBE			1	TU44-102P	
QServa riiviv astus160	Keeper- Schliessblech- Tole- Lamiera- Aldaba de candado- 160			1	TU44-102P	
QNA1 4x40M	Nail- Nagel- Clou- Chiodo- Clavo- 1.4x40mm			50	FIB2-1	
QNA2 2x50Zn	Nail- Nagel- Clou- Chiodo- Clavo- 2.5x50mm			350	FB2-1	
QNA3 x70ZN	Nail- Nagel- Clou- Chiodo- Clavo- 3x70mm			500	RB2-1	
QKR3x 16ZNY	Screw- Schraube- Vis- Vite- Tornillo- 3x16mm ZnY			3		
QKR3x 16kZN	Screw- Schraube- Vis- Vite- Tornillo- 3x16mm kZN			2		
QKR4 5x50ZN	Screw- Schraube- Vis- Vite- Tornillo- 4.5x50mm			250	EaEx; FaBx-x; Sisx-x	
QKR4 5x70ZN	Screw- Schraube- Vis- Vite- Tornillo- 4.5x70mm			12	TU44-102P 4pcs 001; 007; 008	
QKR5 x90ZN	Screw- Schraube- Vis- Vite- Tornillo- 5x90mm			28	004; 005; 006	
QKR6x 150ZN	Screw- Schraube- Vis- Vite- Tornillo- 6x150mm			24	AR1+AR2	
QKR6x 180ZN	Screw- Schraube- Vis- Vite- Tornillo- 6x180mm			14	RoR1	
KL1	Threaded rod- Gewindestangen- Barre fileté- Asta filettata- Varilla roscada M8			4		2000
KL2	Threaded rod- Gewindestangen- Barre fileté- Asta filettata- Varilla roscada M8			2		260
KL3	Threaded rod- Gewindestangen- Barre fileté- Asta filettata- Varilla roscada M8			2		150

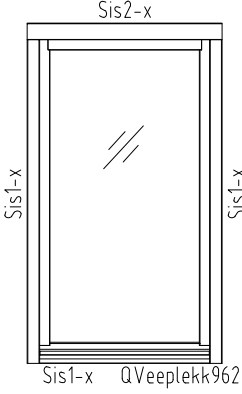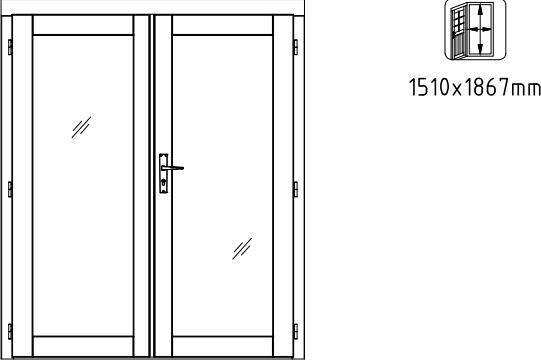

Pos	SPECIFICATION-STÜCKLISTE-NOMENCLATURE-ELEMENTI-ESPECIFICACIÓN PM44-434	Pcs	
	Nut- Schraubenmutter- Écrou- Dado- Tuerca- M8mm 	4	KLx
	Washer- Dichtscheibe- Joint- Rondella- Arandela- 8x22mm 	4	KLx
	Extension nut- Verlängerungsmutter- Écrou rallonge- Dado di prolunga- Tuerca de extensión- JM8 	4	KLx
	Captive nut- Einschlagmutter- Écrou a griffes- Dado a ragno filettatura- Tuerca arana- LM8 	4	KLx
A44-68	<p style="text-align: center;">Window - Fenster - Fenetre - Finestra-Ventana 1000x1780</p> 	1	
TU44-102P	<p style="text-align: center;">Door - Tür - Porte - Porta-Puerta 1610x1936</p> 	1	



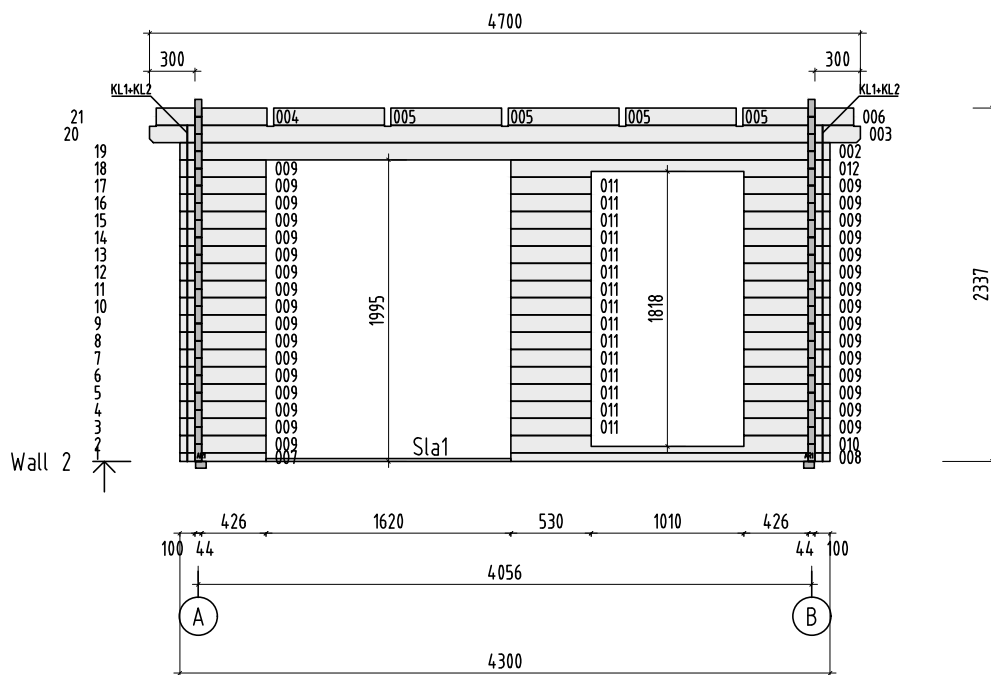

Object name
PM44-434


Drawing
WALL 2

Scale 1:50
Paper A4




Palmako
LEMEKS GROUP

AS Palmako
Näituse 25, Tartu 50409, Estonia
tel. +372 73 55 530
fax. +372 73 55 544
www.palmako.com

Customer	ST	Log	44x114
Drawn by	350		
Date	02.10.2017	File	Heidi_11.7_m2.dwg

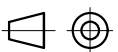

Page 5

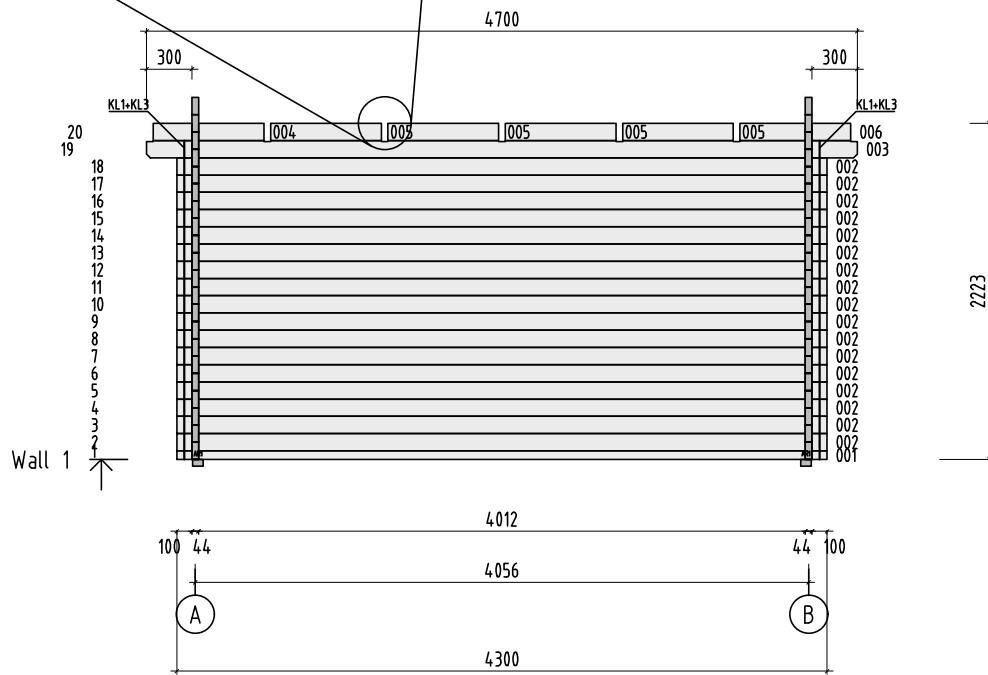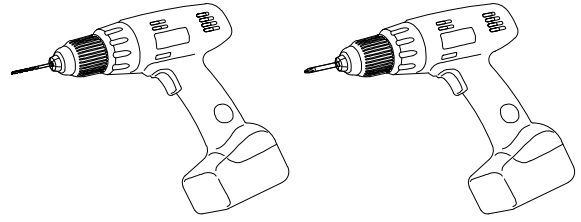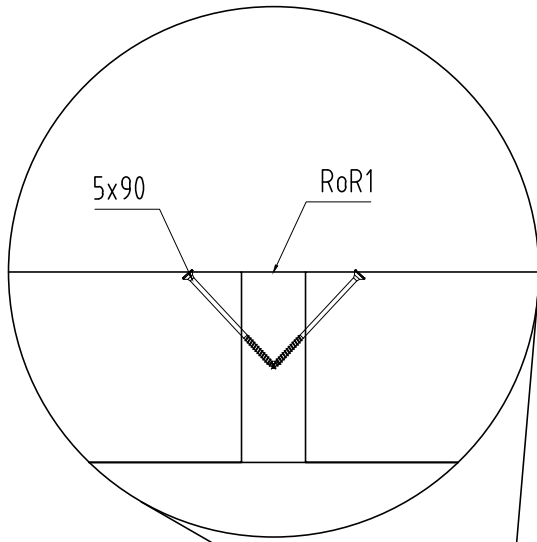

Object name
PM44-434

Drawing
WALL 1







Scale 1:50
Paper A4


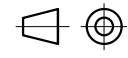



AS Palmako
Näituse 25, Tartu 50409, Estonia
tel. +372 73 55 530
fax. +372 73 55 544
www.palmako.com

Customer	ST	Log	44x114
Drawn by	350		
Date	02.10.2017	File	Heidi_11.7_m2.dwg

Page 4

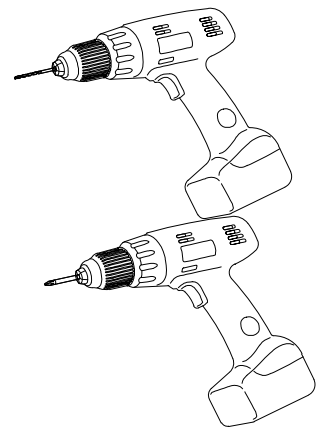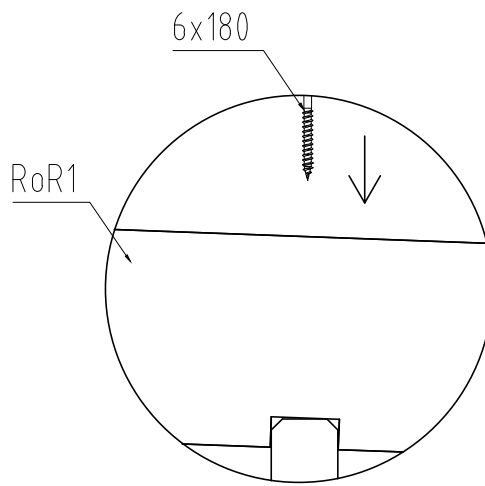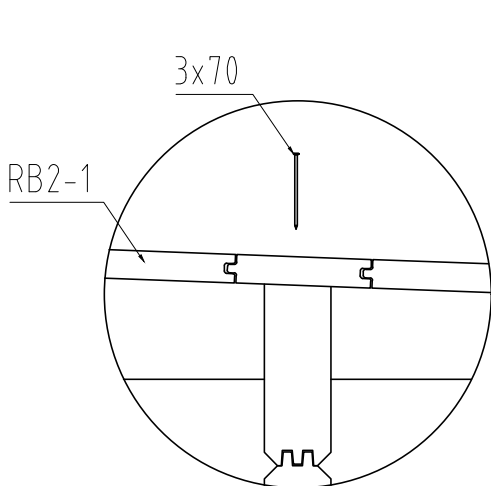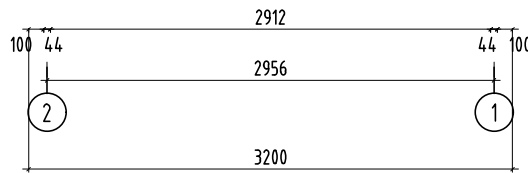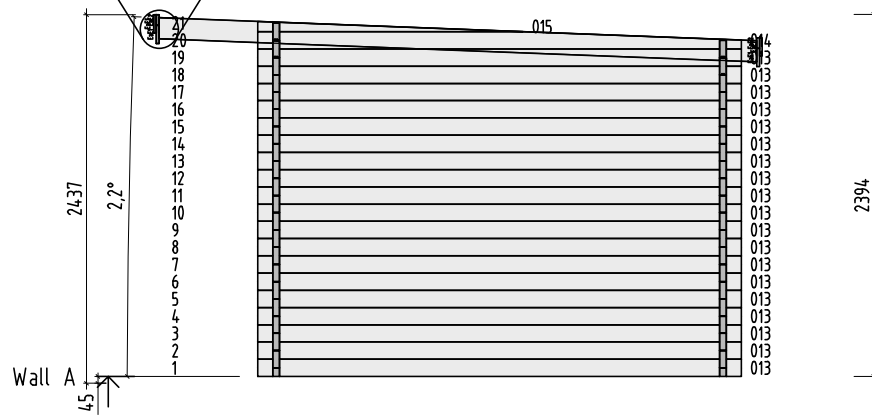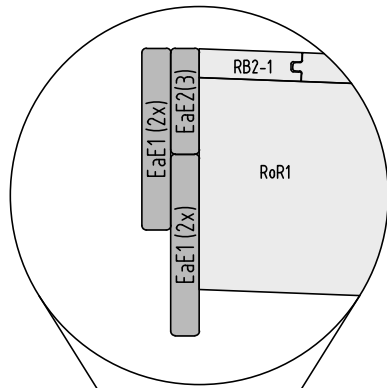

Object name PM44-434	Drawing WALL A		Scale 1:50	
			Paper A4	
 AS Palmako Näituse 25, Tartu 50409, Estonia tel. +372 73 55 530 fax. +372 73 55 544 www.palmako.com	Customer ST	Log 44x114		
	Drawn by 350			
	Date 02.10.2017	File Heidi_11.7_m2.dwg		Page 2

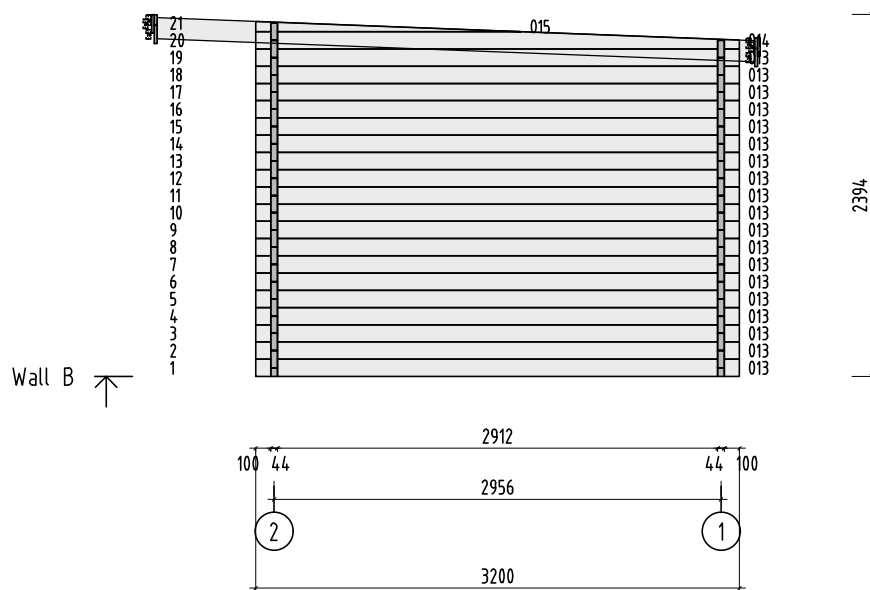

Object name
PM44-434


Drawing
WALL B

Scale 1:50
Paper A4

Palmako
LEMEKS GROUP

AS Palmako
Näituse 25, Tartu 50409, Estonia
tel. +372 73 55 530
fax. +372 73 55 544
www.palmako.com

Customer	ST	Log	44x114
Drawn by	350		
Date	02.10.2017	File	Heidi_11.7_m2.dwg

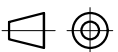

Page 3

1 General information



Dear client,

We are glad that you have decided in favour of our garden house!

Please read the assembly manual carefully before proceeding with the house installation! You will thus avoid problems and will not waste time.

Recommendations:

- Keep the house package until its complete assembly in a dry place, but not in direct contact with the ground, protected from weather conditions (moisture, the sun, etc.). Do not keep the house package in a heated room!
- When selecting the garden house location, make sure that the house will not be subjected to extreme weather conditions (areas of strong snowfall or winds); otherwise you should attach the house (for instance, with anchors) to the subsoil.



Warranty

Your house is made from high quality fir and delivered in the natural (unprocessed) form. If, despite our thorough inspection, you should have complaints, please submit the filled out control sheet and purchase invoice to the product seller.

ATTENTION: Please be sure to keep the documentation accompanying the house package! The control sheet includes the control number of the house. We can only review complaints if you submit the control number of the house to the seller!

The warranty does not cover:

- Peculiarities of wood as a natural material
- Wooden details already painted (processed with a wood preservative)
- Wooden details containing whole branches that do not endanger the stability of the house
- Colour tone variations caused by wood structure differences that do not influence wood lifetime
- Wooden details containing (caused by drying) small cracks/gaps that do not pass through and do not influence the structure of the house
- Twisted wooden details if they can nevertheless be installed
- Roof and floor boards that may have on their concealed surfaces some non-planed areas, colour differences and waning
- Complaints resulting from an incompetent manner of the installation of the house or the house subsiding due to an incompetently made foundation
- Complaints caused by introducing self-initiative changes to the house, such as the deformation of wooden details and doors/windows due to an incompetent manner of wood processing; the attachment of storm braces too rigidly, doorframes being screwed onto wall logs, etc.

The complaints covered by the warranty are satisfied to the extent of replacing the deficient/faulty material. All other demands will be excluded!



Garden house painting and maintenance

Wood is a natural material, growing and adapting depending on weather conditions. Large and small cracks, colour tone differences and changes, as well as a changing structure of wood are not errors, but a result of wood growing and a peculiarity of wood as a natural material.

Unprocessed wood (except for foundation joists) becomes greyish after having been left untouched for a while, and can be turn blue and become mouldy. To protect the wooden details of your garden house, you must immediately process them with a wood preservative.

We recommend that you cover the floor boards in advance with a colourless wood impregnation agent, especially the bottom sides of the boards, to which you will no longer have access when the house is assembled. Only this will prevent moisture penetration.

We definitely recommend that you also process the doors and windows with a wood impregnation agent, and do that namely both inside and outside! Otherwise the doors and windows can become twisted.

After the house assembly is completed, we recommend for the conclusive finishing a weather protection paint that will protect wood from moisture and UV radiation.

When painting, use high quality tools and paints, follow the paint application manual and manufacturer's safety and usage instructions. Never paint a surface in strong sunlight or rainy weather. Consult a specialist regarding paints suitable for unprocessed softwood and follow the paint manufacturer's instructions.

Having been properly painted, your garden house's lifetime will increase substantially. We recommend that you inspect the house thoroughly once every six months.

2 Preparation for assembly

Tools and preparation of components

To assemble the garden house, you will need the following tools:



assembly aid



ladder



hammer



water-level



screwdriver



saw



knife



measuring tape



pliers



drill

ADVICE: To avoid splinters, we recommend that you wear the corresponding protective gloves during the assembly process.



We wish you total success with the garden house installation and much joy with this house for many years to come!